
NORTHSIDE NEIGHBORHOOD IMPROVEMENT PLAN DILLARD STREET AND ALLEY IMPROVEMENTS


CITY OF
MARTINSVILLE, VIRGINIA
AUGUST 2016
CDBG CIG No. 13-14

SHEET LIST:

- 1. TITLE SHEET
- 2. TYPICAL SECTIONS AND NOTES
- 3. PLAN DILLARD STREET PAVING
- 4. PLAN EXISTING ALLEY EXTENSION OFF OF DILLARD ST. AND ENTRANCE OFF OF WARREN COURT
- 5. PROFILES ALLEY AND ENTRANCES
- 6. ROADSIDE DEVELOPMENT

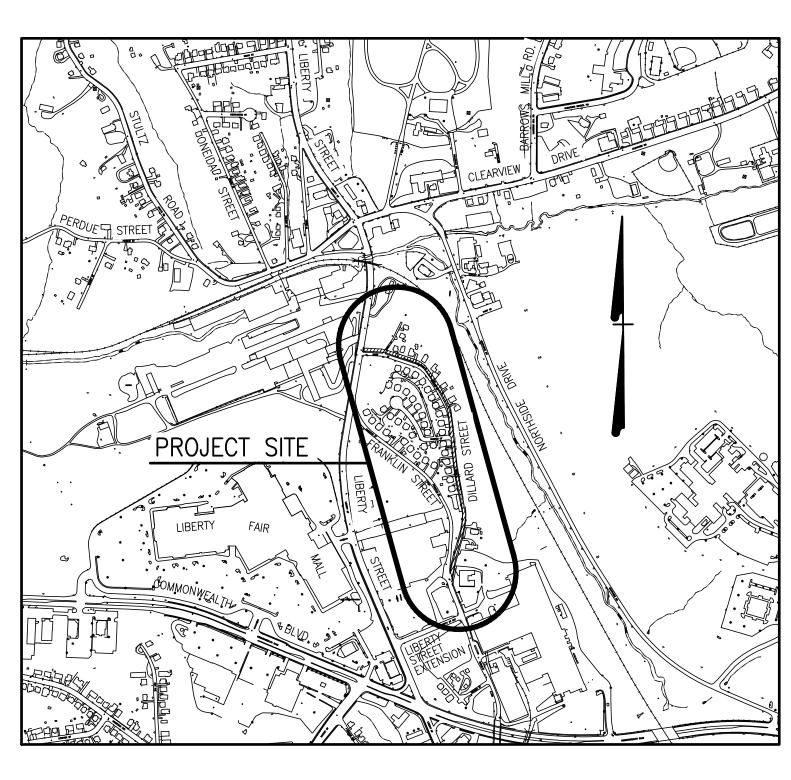


SCALE: NONE

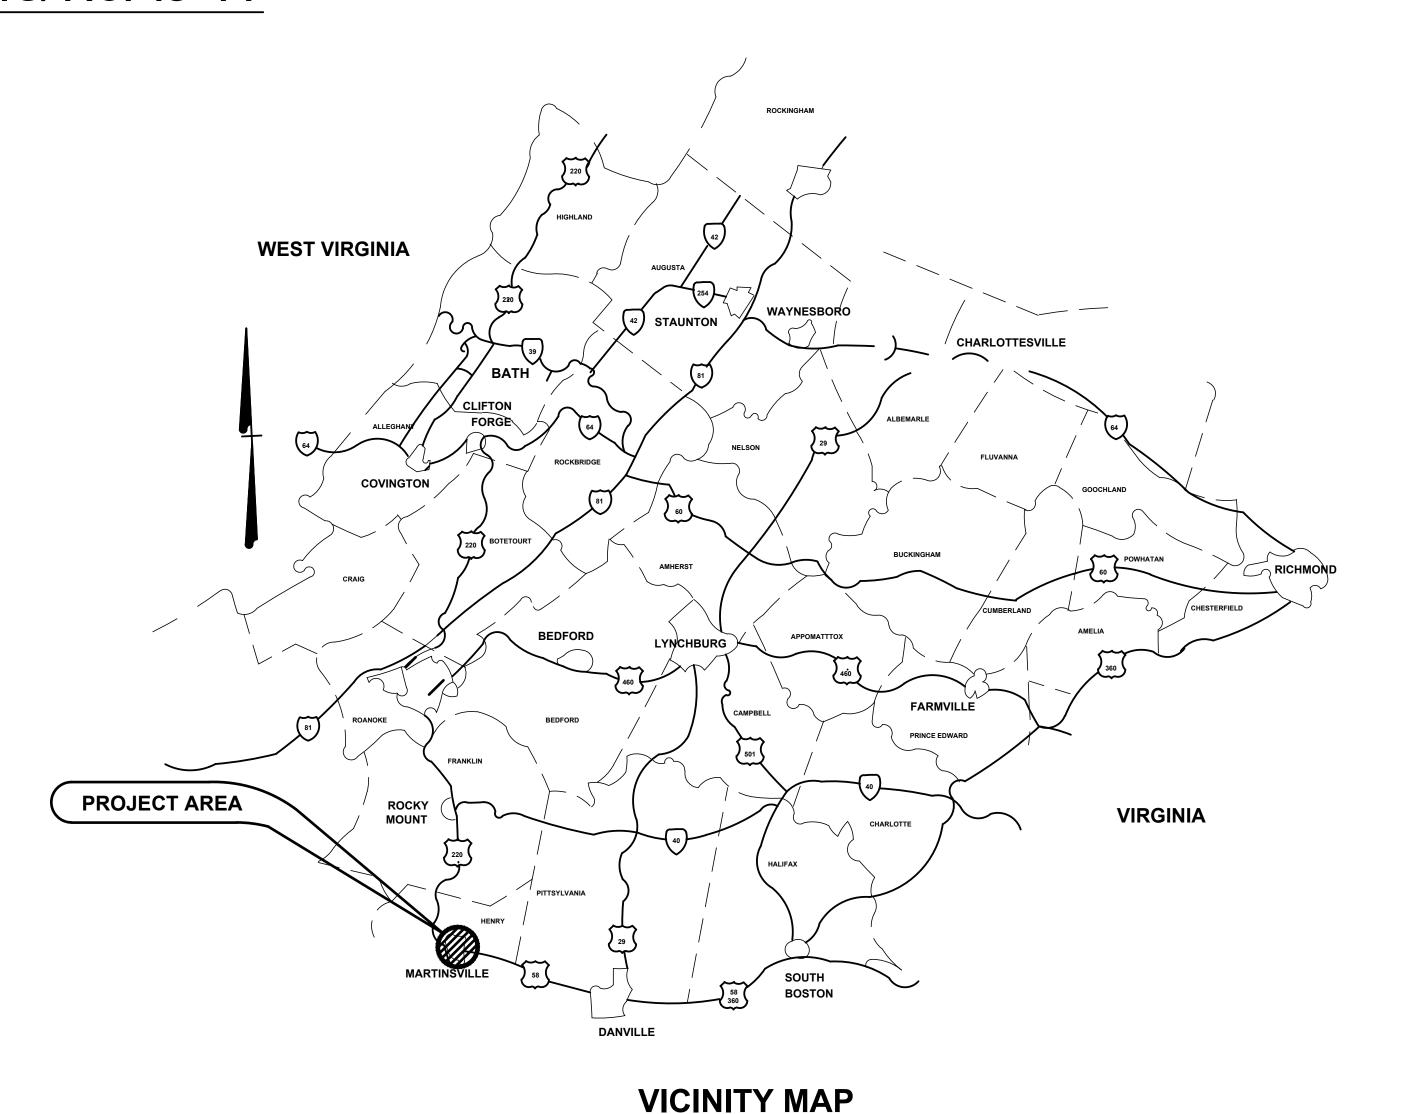

MARTINSVILLE, VIRGINIA

SCALE: NONE

WICH COMPANY OF THE PROPERTY O

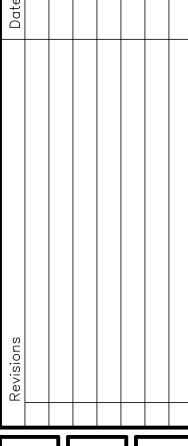

August 14, 2016

Drawn By: RSM

Designed By: RSM

Checked By: MSA

Date: 8/10/16

Mattern & Craig
ENGINEERS• SURVEYORS
701 FIRST STREET, S.W.
ROANOKE, VIRGINIA 24016
(540) 345-9342
FAX (540) 345-7691

SDE NEIGHBON 1900 IMM NOVEMENTS

LE SHEET

Vertical Scale: NO SCALE

NO SCALE

Sheet No.:

SET NO.

GENERAL NOTES:

- THIS PROJECT IS TO BE CONSTRUCTED IN ACCORDANCE WITH THE PROJECT SPECIFICATIONS, THESE PLANS, VDOT ROAD AND BRIDGE SPECIFICATIONS DATED 2007, VDOT ROAD AND BRIDGE STANDARDS DATED 2008, AND THE VIRGINIA WORK AREA PROJECTION MANUAL, REV. 1. DATED AUGUST 2011 AND AS AMENDED BY CONTRACT PROVISIONS AND THESE PLANS. THE CONTRACTOR SHALL NOTIFY THE CITY OF MARTINSVILLE CITY ENGINEER 24 HOURS BEFORE COMMENCING CONSTRUCTION.
- CONTRACTOR SHALL MAINTAIN TWO-WAY TRAFFIC AT ALL TIMES, UNLESS OTHERWISE ALLOWED BY THE CITY.
- THE PLAN SET IS INCOMPLETE UNLESS ACCOMPANIED BY THE PROJECT MANUAL. LIKEWISE, THE PROJECT MANUAL IS INCOMPLETE UNLESS ACCOMPANIED BY THE PLANS.
- 4. THE CONTRACTOR SHALL CONTACT "MISS UTILITY" (1-800-552-7001) AT LEAST 48 HOURS BEFORE BEGINNING LAND DISTURBING ACTIVITIES TO OBTAIN FIELD UTILITY LOCATIONS. CERTAIN UTILITIES WITHIN THE VICINITY OF THE PROJECT AREA ARE SHOWN ON THE PLANS. THE UTILITIES SHOWN ARE NOT GUARANTEED TO BE COMPLETE OR ACCURATELY LOCATED. THE CONTRACTOR IS RESPONSIBLE FOR LOCATION OF ALL EXISTING UTILITIES, INCLUDING WATER LATERALS, SANITARY SEWER LATERALS, GAS LATERALS, ETC. AND LIGHTING SYSTEMS BEFORE PROCEEDING WITH WORK.
- CONTRACTOR SHALL TOPSOIL, MULCH AND SEED ALL DISTURBED AREAS NOT PAVED IN ACCORDANCE WITH THE SPECIFICATIONS.
- 6. ACCESS TO PRIVATE ENTRANCES SHALL BE MAINTAINED AT ALL TIMES.
- ALL GRADING AND PAVING SHALL BE PERFORMED IN SUCH A MANNER AS TO ELIMINATE FALSE GUTTERS AND/OR PONDED WATER.
- 8. THE PAVEMENT MATERIALS ON THIS PROJECT WILL BE PAID FOR ON A TONNAGE BASIS. THE WEIGHT WILL VARY IN ACCORDANCE WITH THE SPECIFIC GRAVITY OF THE AGGREGATES AND THE ASPHALTIC CONTENT OF THE MIX ACTUALLY USED TO SECURE THE DESIGN DEPTH. THE WEIGHT OF THE ASPHALT CONCRETE IS BASED ON 95% OF THE THEORETICAL MAXIMUM DENSITY.
- CLEARING AND GRUBBING SHALL BE CONFINED TO THOSE AREAS NEEDED FOR CONSTRUCTION. NO TREES OR SHRUBS IN UNGRADED AREAS SHALL BE CUT WITHOUT THE PERMISSION OF THE ENGINEER.
- 10. CONTRACTOR SHALL SAW CUT EXISTING PAVEMENT (EXISTING SURFACE AND BASE ASPHALT MATERIAL) ADJACENT TO PROPOSED CONSTRUCTION ITEMS.
- 11. CONTRACTOR SHALL PROVIDE NO. 25 OR 26 CRUSHER RUN AGGREGATE FOR TEMPORARY RESIDENTIAL PARKING AS DIRECTED BY THE CITY OF MARTINSVILLE. COST OF MATERIAL AND THIS WORK SHALL BE INCLUDED IN COST BID FOR OTHER ITEMS.
- 12. CDBG PROJECT SIGN IS NOT REQUIRED FOR THIS PROJECT.

COORDINATES: ALLEY EXTENSION B

PI STA. 10+00.00 N11079900.64 E3417825.55 PI STA. 11+14.77 N11079864.04 E3417717.02

PI STA. 12+23.10 N11079982.16 E3417704.53

PI STA. 12+80.22 N11080036.39 E3417683.60

PI STA. 11+73.23 N11079932.01 E3417698.03

PI STA. 13+58.22 N11080099.40 E3417637.63

PI STA. 13+80.00 N11080119.85 E3417614.04

COORDINATES: ENTRANCE A B

PI STA. 10+00.00 N11079941.66 E3417491.81

POT STA. 10+74.99 N11079886.94 E3417440.52

PI STA. 11+03.50 N11079866.15 E3417421.02

PI STA. 11+33.00 N11079889.39 E3417390.91

COORDINATES: ENTRANCE B B

PC STA. 29+85.86 N11079886.94 E3417440.52

PI STA. 30+08.37 N11079870.53 E3417425.12

PI STA. 30+51.00 N11079832.26 E3417458.20


PI STA. 31+05.00 N11079798.12 E3417500.13

BENCH MARK: PK NAIL IN POWER POLE AT INTERSECTION OF DILLARD STREET AND PROPOSED ALLEY ENTRANCE STA. 10+00 POLE NO. MED#15 ELEV. 813.21

EROSION AND SILTATION CONTROL

THE TEMPORARY EROSION AND SILTATION CONTROL ITEMS SHOWN ON THE E&S CONTROL PLAN ARE INTENDED TO PROVIDE A GENERAL PLAN FOR CONTROLLING EROSION AND SILTATION WITHIN THE PROJECT LIMITS. THE E&S CONTROL PLAN IS BASED ON FIELD CONDITIONS AT THE TIME OF PLAN DEVELOPMENT AND AN ASSUMED SEQUENCE OF CONSTRUCTION. THE CONTRACTOR, IN CONJUNCTION WITH THE PROJECT ENGINEER AND/OR ENVIRONMENTAL MONITOR, SHALL ADJUST THE LOCATION, QUANTITY AND TYPE OF EROSION AND SILTATION CONTROL ITEMS REQUIRED BASED ON THE ACTUAL FIELD CONDITIONS ENCOUNTERED AT THE TIME OF CONSTRUCTION AND THE SELECTED SEQUENCE OF CONSTRUCTION.


THE AREAS BEYOND THE PROJECT'S CONSTRUCTION AREA ARE TO BE PROTECTED FROM SILTATION. PERIMETER CONTROLS SUCH AS FILTER BARRIER, SILT FENCE, DIVERSION DIKES, TURBIDITY CURTAINS, ETC. SHALL BE INSTALLED PRIOR TO ANY GRUBBING OPERATIONS OR OTHER EARTH MOVING ACTIVITIES.

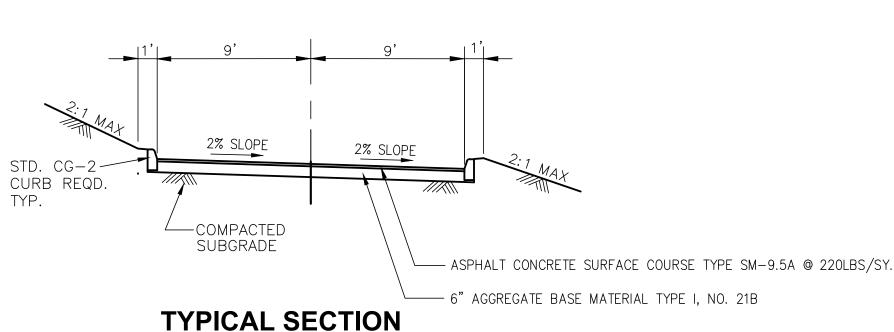

ALLEY EXTENSION

(OFF OF DILLARD STREET) NO SCALE

STA 10+00.00 TO 10+88.43. DO NOT CROWN PVMT., 2% CROSS SLOPE FROM EP TO EP DOWN TO THE WEST SIDE OF ALLEY.

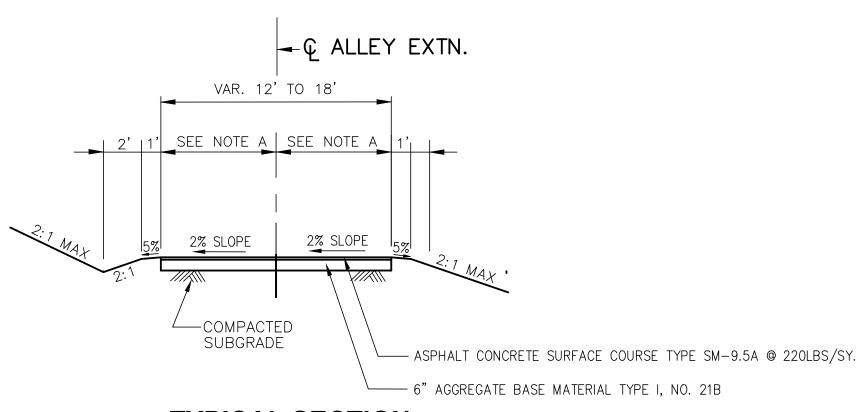

TYPICAL SECTION **ALLEY EXTENSION**


(OFF OF DILLARD STREET) NO SCALE

NOTE A:

VARIABLE WIDTH (9' TO 6' TRANSITION) FROM STA 10+88.43 TO 11+29.00


6' WIDE FROM STA 11+29.00 TO 11+98.97. DO NOT CROWN PVMT., 2% CROSS SLOPE FROM EP TO EP DOWN TO THE NORTH SIDE OF THE ALLEY.


STA. 11+98.97 TO 13+80.00-CROWN PVMT. AT C MAINTAIN EXISTING ALLEY WIDTH AND GRADE. NO SHOULDER OR DITCH IMPROVEMENT REQUIRED.

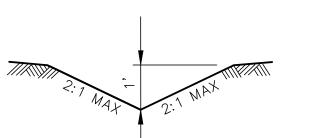


VDOT STD EC-3, TYPE B SOIL STABILIZATION MAT REQD.


DITCH DETAIL A NO SCALE

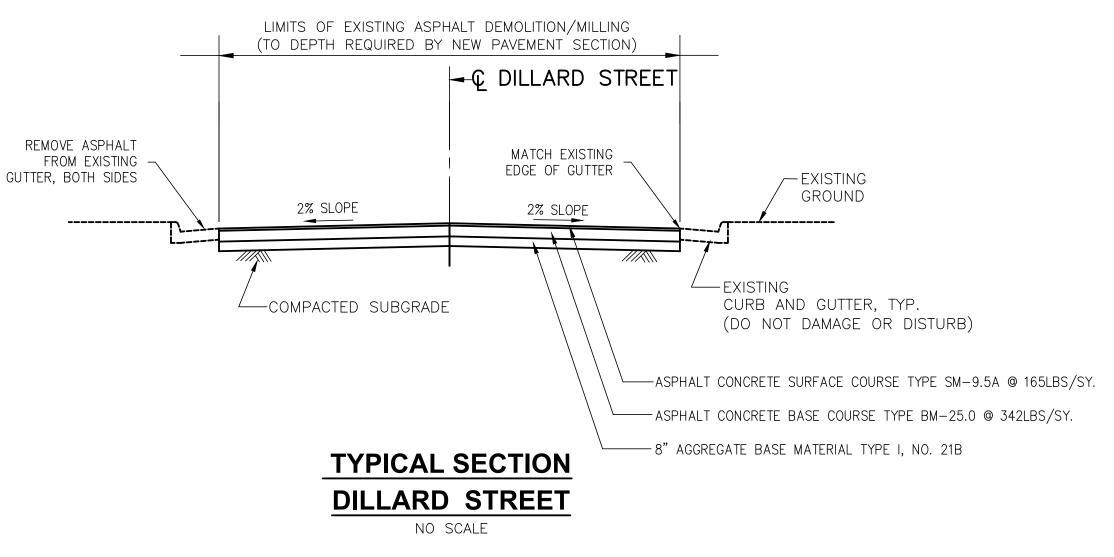

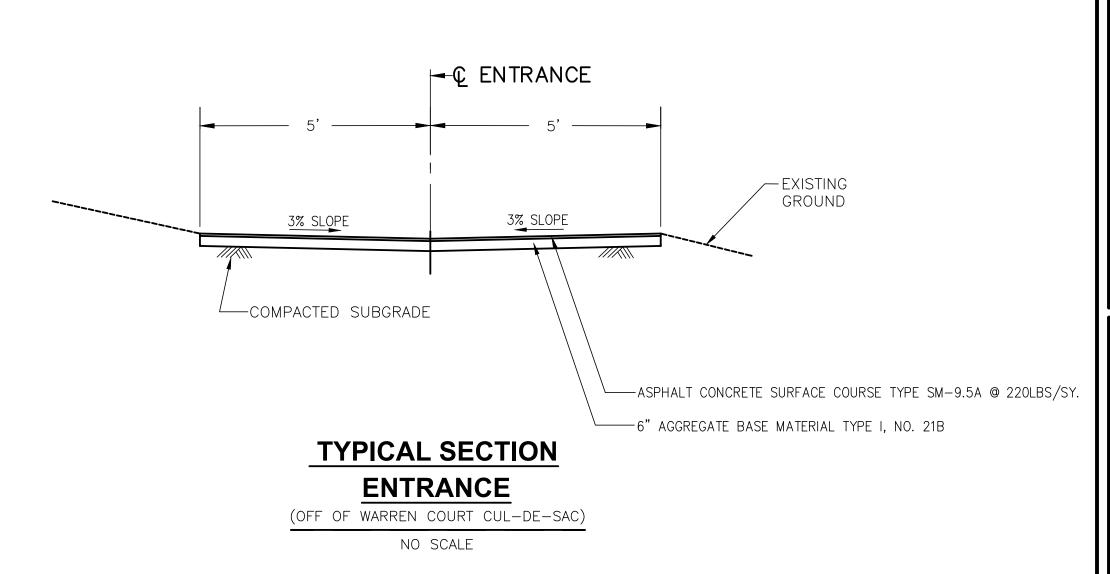

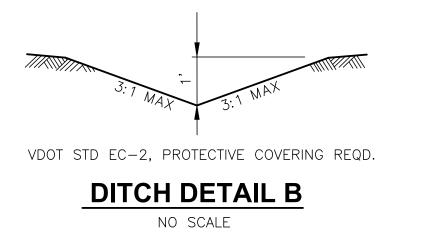



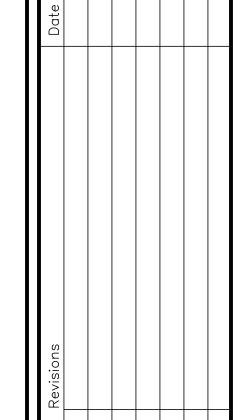



NOTE: TIONS USION (OFF DF WARREN


Vertical Scale: NO SCALE

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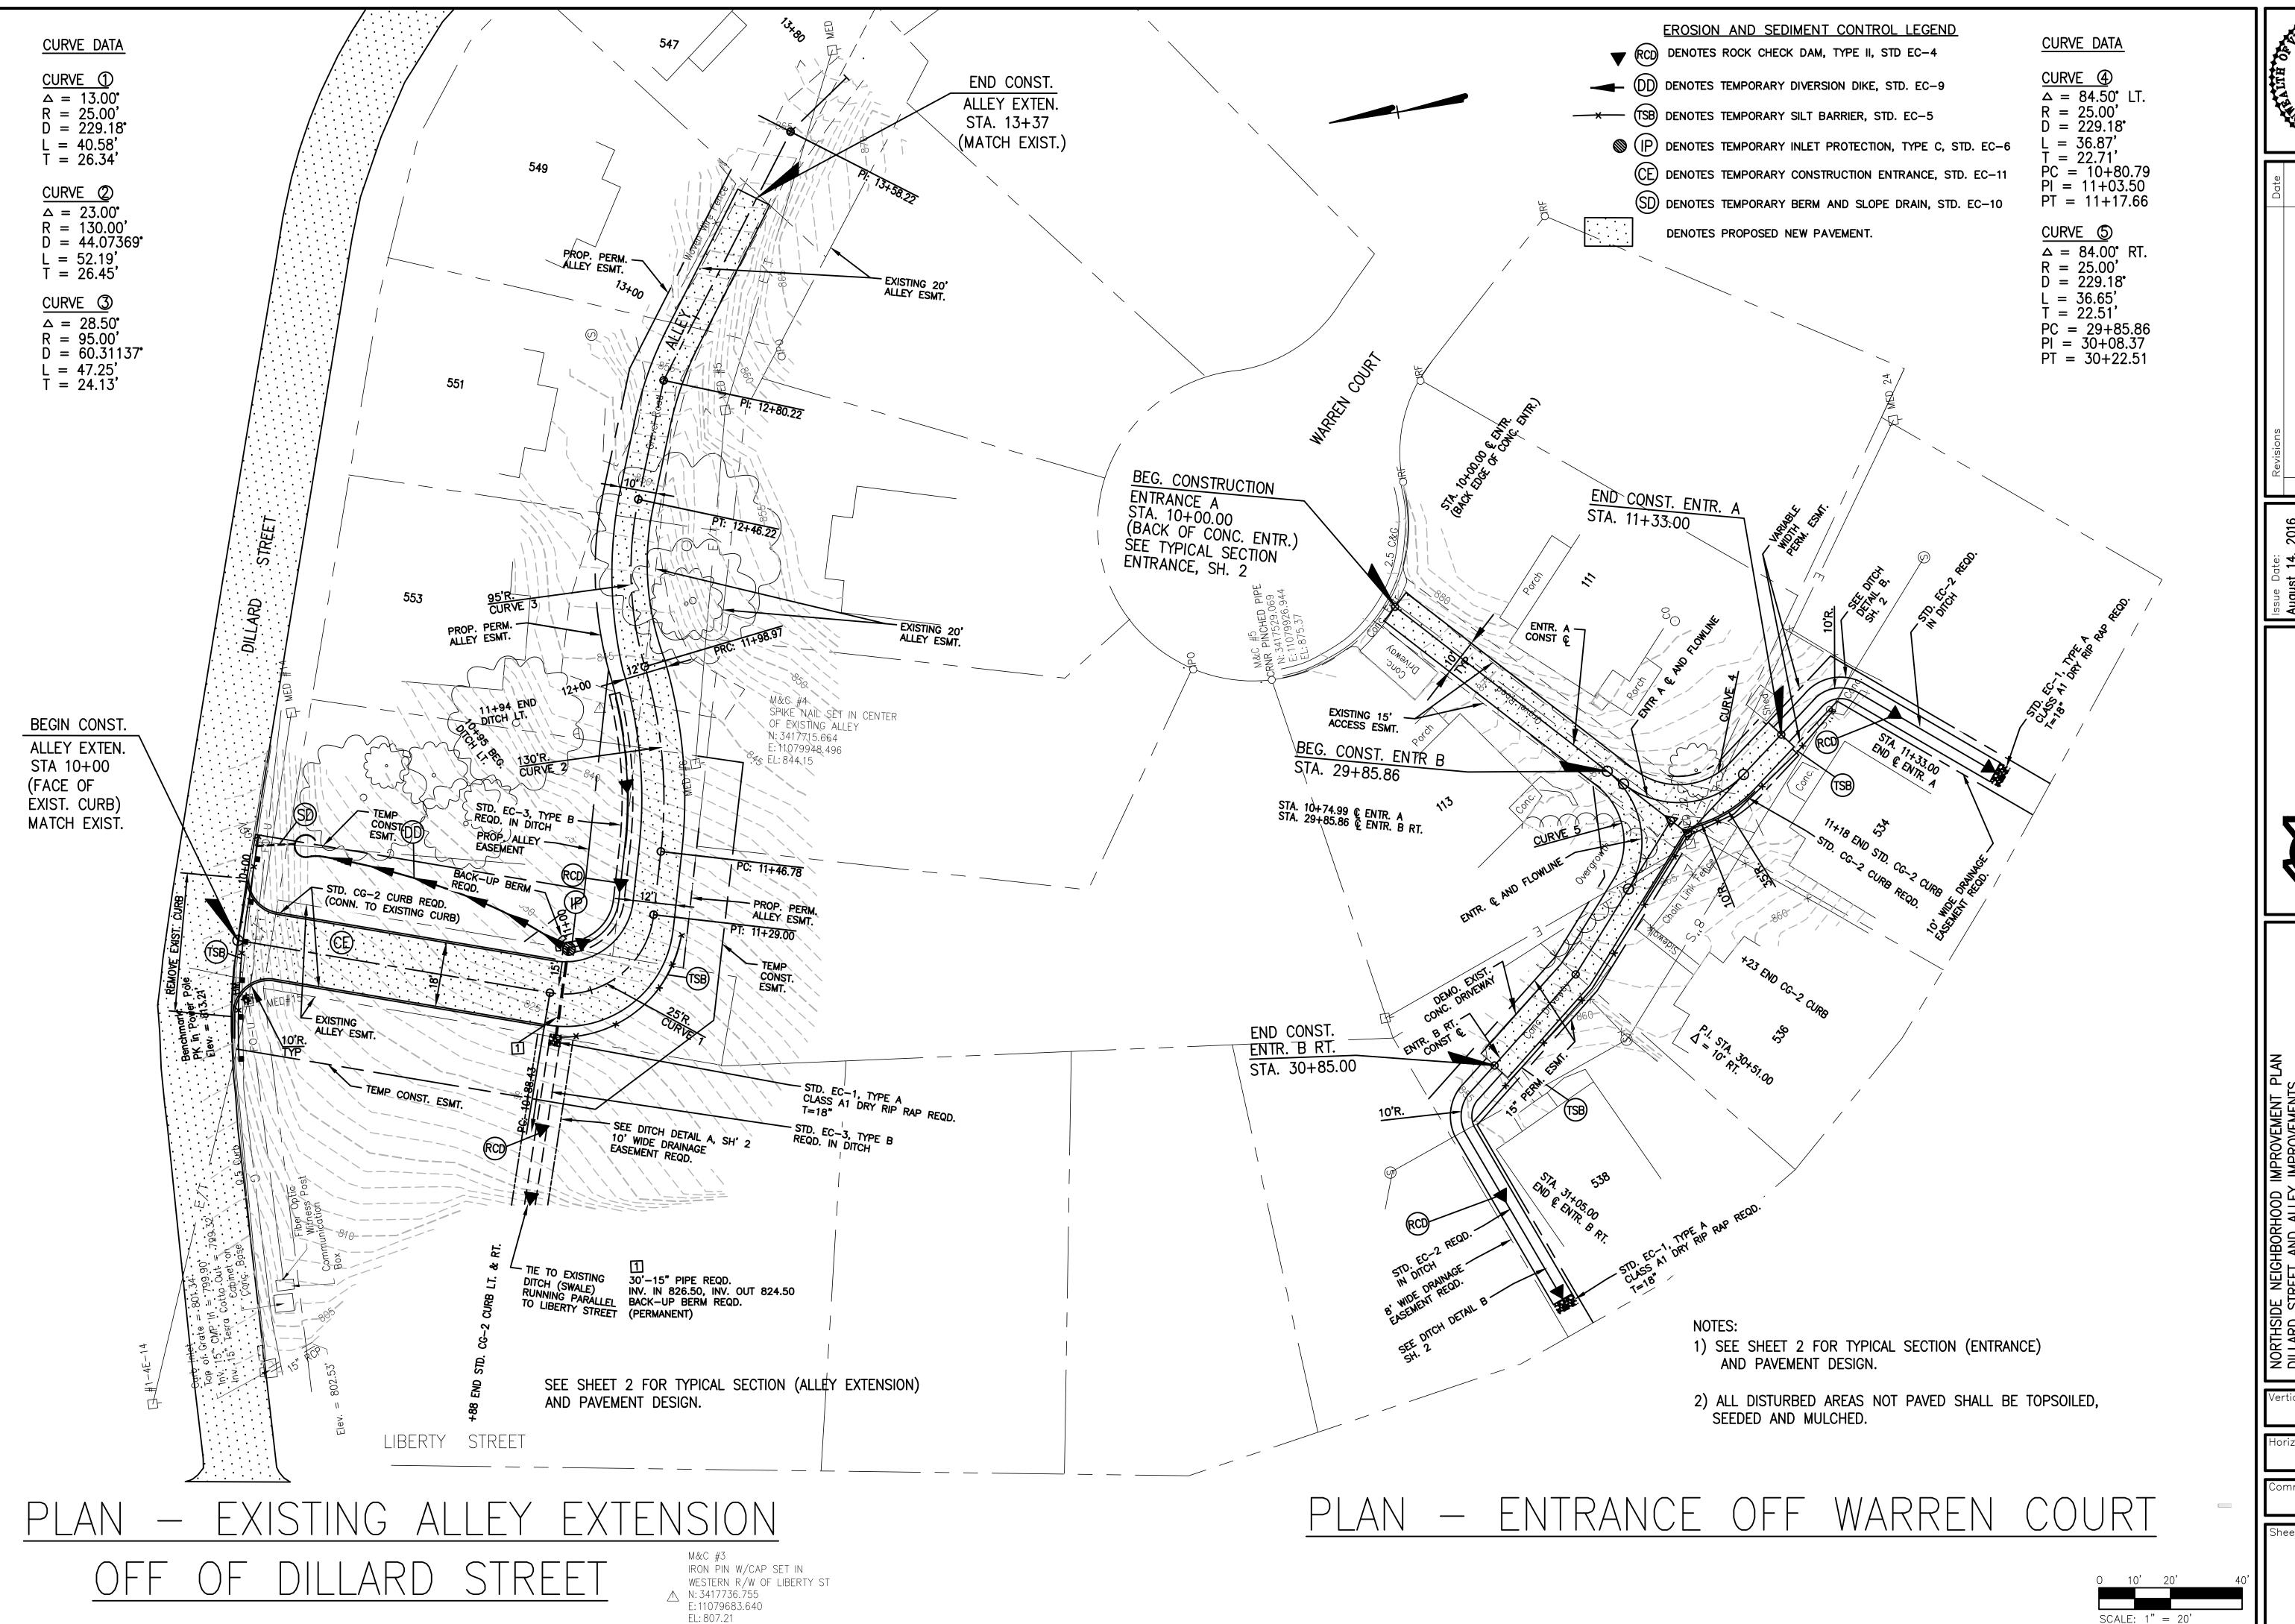
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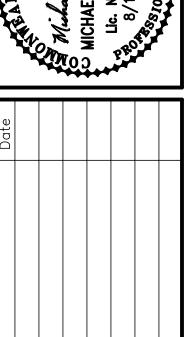




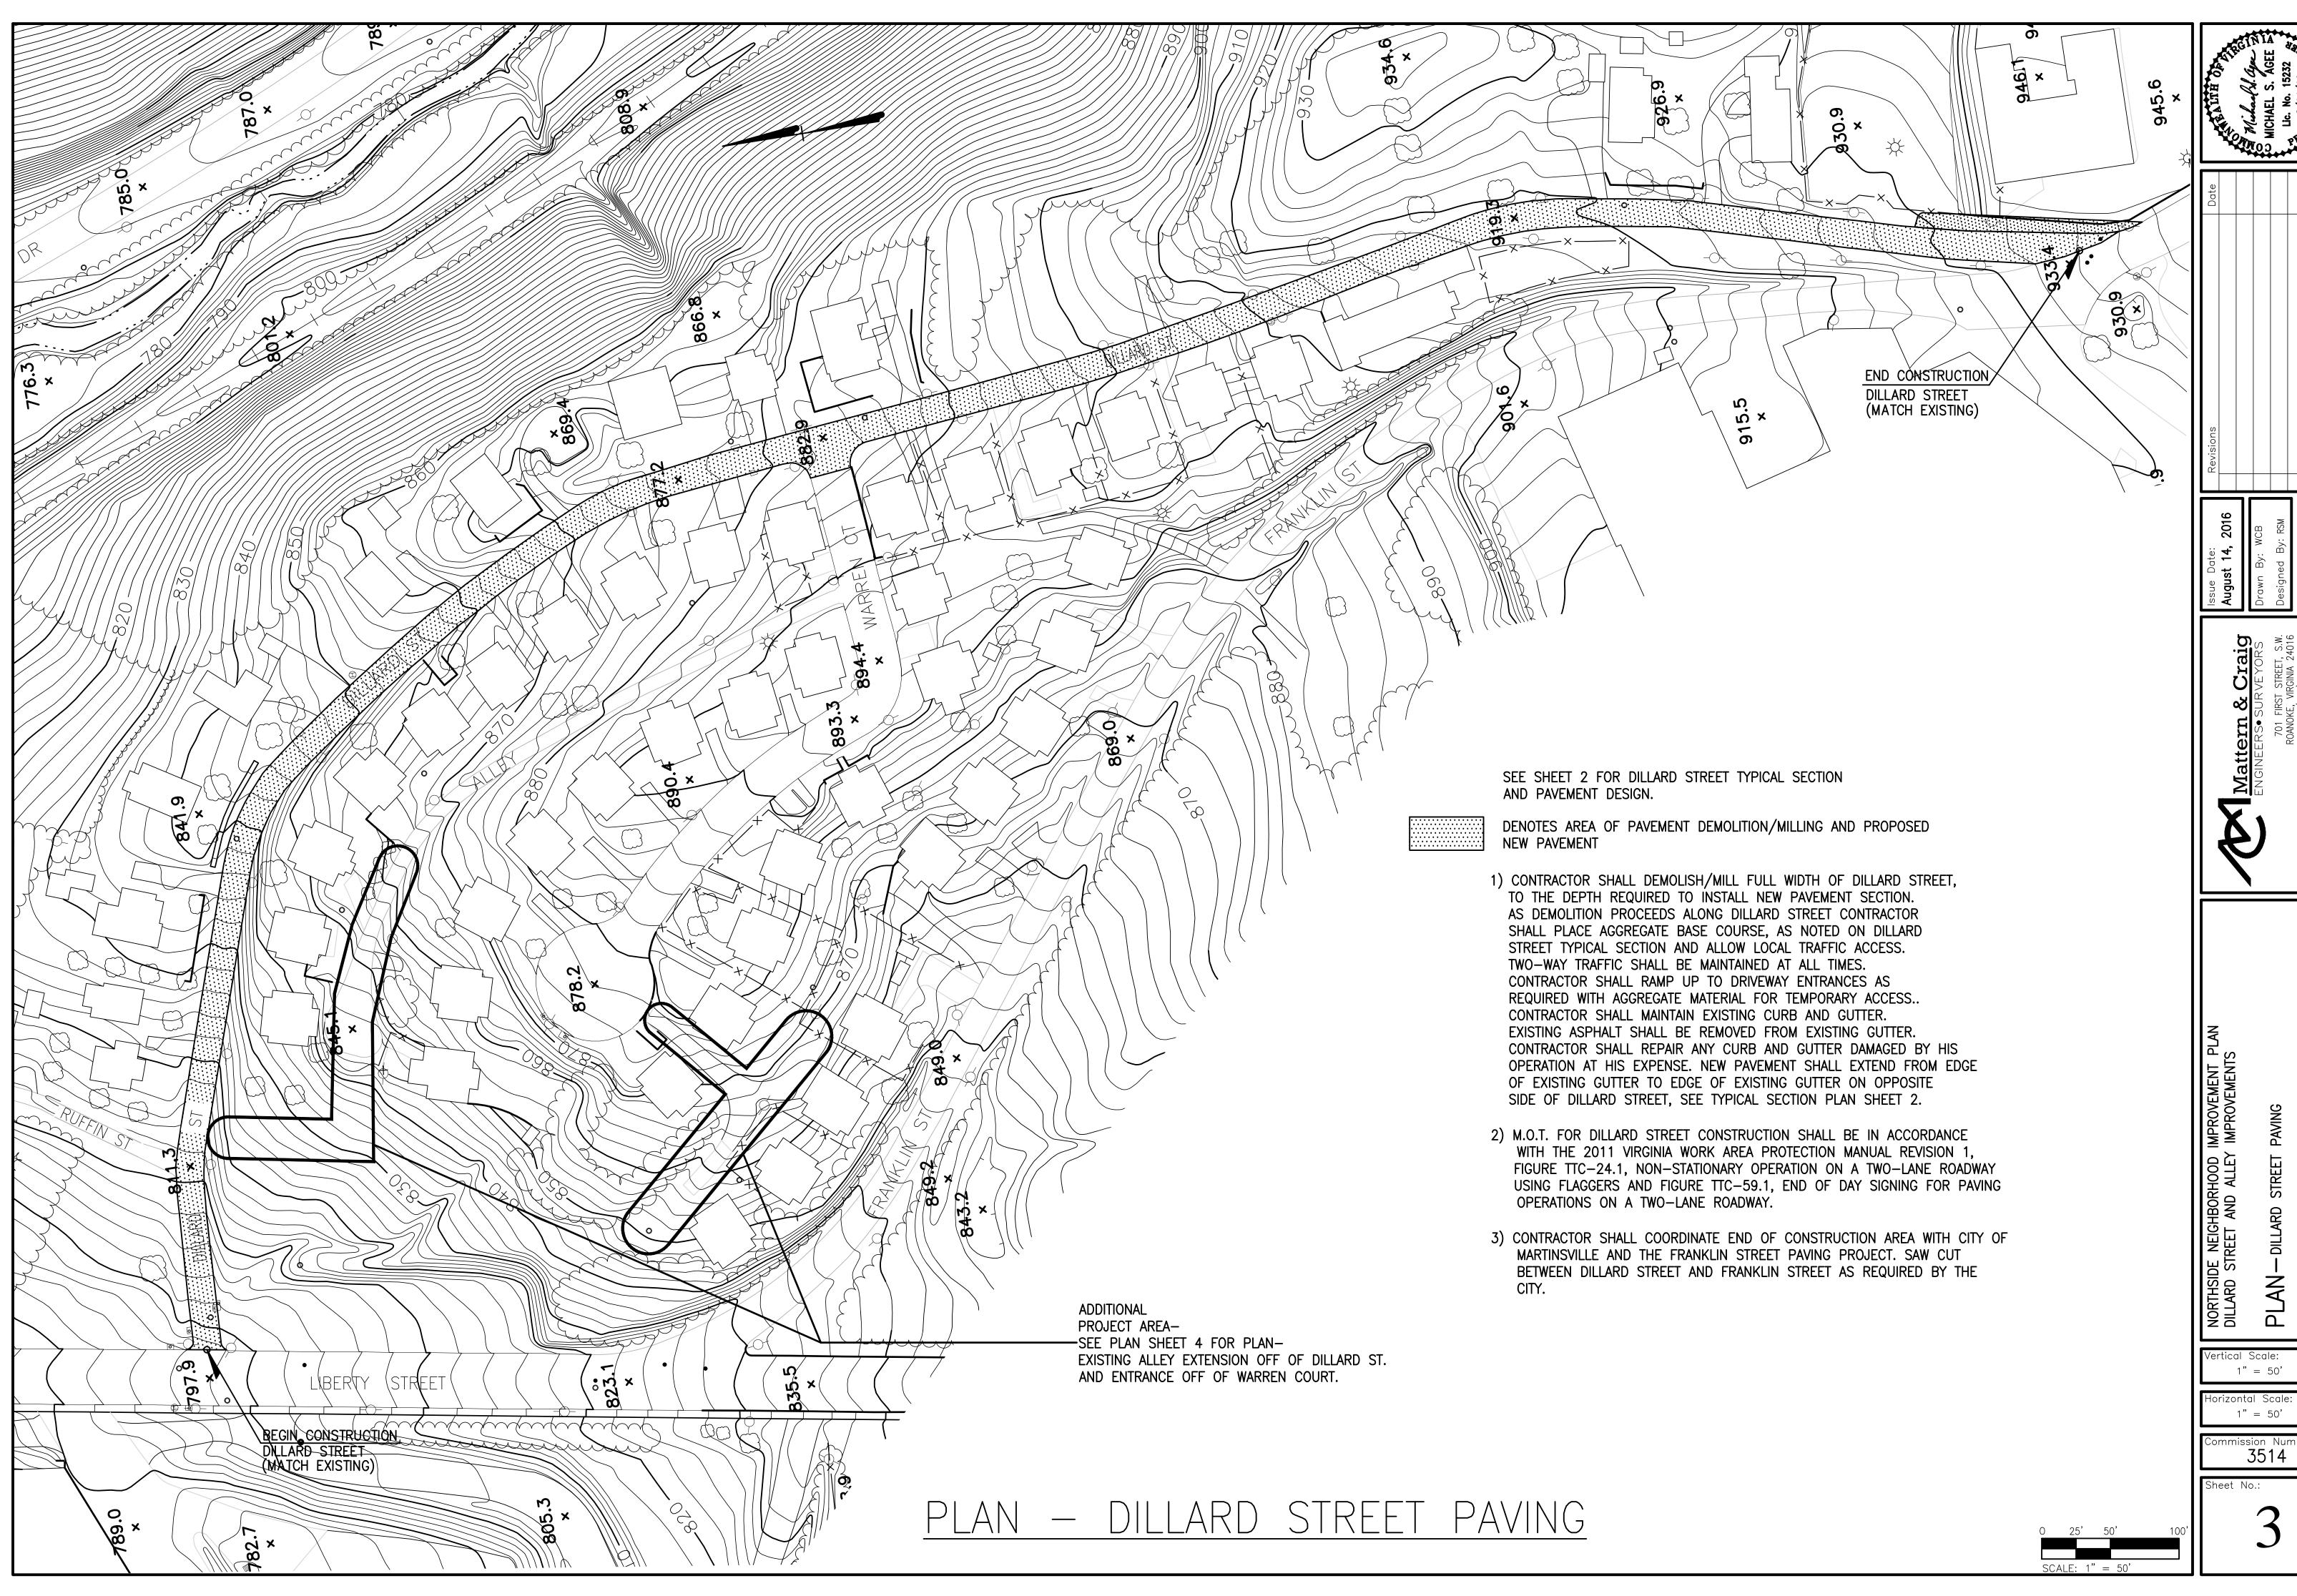

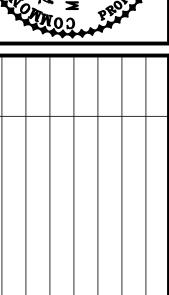mmission Number: 3514

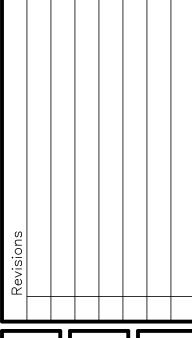





Vertical Scale:

1" = 20'

3514

NORTHSIDE NEIGHBORHOOD IMPROVEMENT PLAN DILLARD STREET AND ALLEY IMPROVEMENTS AND

PROFILES-

Vertical Scale:

ommission Number: 3514

ROADSIDE DEVELOPMENT

CORE MIX


- CONCENTION							
MIX	LBS./ ACRES	DESCRIPTION					
1	200	* 100% CERTIFIED FINE FESCUE					
2	100	100% CERTIFIED TALL FESCUE					
3	A	50% CERTIFIED TALL FESCUE					
3		* 50% CERTIFIED FINE FESCUE					
4	A	50% ORCHARDGRASS					
4		50% CERTIFIED KENTUCKY BLUEGRASS					
5		100% BERMUDAGRASS					
TEMPORARY							
3/1 - 5/16 AND	50	50% CERTIFIED TALL FESCUE					
8/16 - 3/1	50	50% BARLEY, WINTER RYE OR WINTER WHEAT					
5/16 - 8/16	50	50% FOXTAIL MILLET					
	50	50% CERTIFIED TALL FESCUE					

ADDITIVES

MIX	LBS./ ACRES	DESCRIPTION			
А	A	100% LOVEGRASS			
В	20	100% BARLEY, WINTER RYE OR WINTER WHEAT			
С	A	100% FOXTAIL MILLET			
D	10	100% ANNUAL RYEGRASS			
E	20	100% CROWNVETCH (LEGUME)			
F	A	100% SERICEA LESPEDEZA (LEGUME)			
G	A	100% BIRDSFOOT TREFOIL (LEGUME)			
Н	10	100% BLUE GRAMA			
ı	A				
J	A				
К	A				

- ▲ ALL RATES TO BE SPECIFIED BY THE ENGINEER.
- * FINE FESCUES INCLUDE CHEWINGS, CREEPING RED, HARD, SHEEP

SECTION OF SEED LOCATIONS

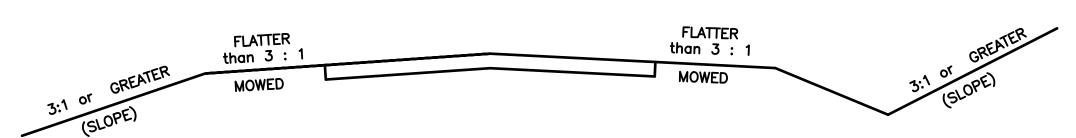

SEEDING SCHEDULE

ROADSIDE DEVELOPMENT SUMMARY									
PROJECT NUMBERS	TOP SOIL 2" CLASS	REGULAR SEED	OVER SEEDING	LIME	FERT. 15-30-15	LEGUME SEED	LEGUME OVER SEED	TEMPORARY SEEDING	
	ACRES	LBS.	LBS.	TONS	TONS	LBS.	LBS.	LBS.	
	0.20	63	39	1	0.10	5	3	20	

	SLOPES SEED MIX WITH ADDITIVE	MOWED SEED MIX WITH ADDITIVE	SLOPES SEED MIX WITH ADDITIVE	MOWED SEED MIX WITH ADDITIVE	SLOPES SEED MIX WITH ADDITIVE	MOWED SEED MIX WITH ADDITIVE
	SPRING MONTH & DATE 4/1 - 6/1		SUM MONTH		FALL & WINTER MONTH & DATE	
			6/1 - 9/15		9/15 - 4/1	
PROJECT NUMBERS	2E	1D	2E	1H	2E	1B
* SPECIFY KIND OF FINE FESCUE	Hard	Hard	Hard	Hard	Hard	Hard

DENOTES ITEMS TO BE PAID FOR ON BASIS OF PLAN QUANTITIES IN ACCORDANCE WITH CURRENT ROAD AND BRIDGE SPECIFICATIONS.

NOTES

APPROXIMATELY 0.20 acres will be disturbed on this project and will require the establishment of grasses and/or legumes.

NOTES FOR FIELD USE ONLY

OVERSEEDING RATES SHALL BE 100 PERCENT OF THE SEED MIXTURE SUPPLIED WITHOUT FERTILIZER.

THE ENGINEER WILL REQUIRE THE CONTRACTOR TO PERFORM SUPPLEMENTAL SEEDING WHEN LESS THAN 75 PERCENT UNIFORM STAND OF THE PERMANENT GRASS SPECIFIED IN THE MIXTURES IS OBTAINED. (ANNUAL SPECIES SUCH AS, RYE AND MILLET ARE TEMPORARY VARIETIES AND REQUIRE SUPPLEMENTAL SEEDING.)

NOTES APPLY TO SCEDULE

LEGUME SEED MIXES (BIRDSFOOT TREFOIL, CROWN VETCH, AND SERICEA LESPEDEZA) AND WEEPING LOVEGRASS SHALL NOT BE USED ON SHOULDERS AND OTHER LOCATIONS FLATTER THAN 3:1 SLOPE.

LEGUME SEED SHALL BE INOCULATED WITH THE APPROPRIATE STRAIN AND RATE OF BACTERIA FOR HYDROSEEDING, USE FIVE TIMES THE DRY SEEDING RATE OF INOCULATE.

A TEMPORARY MIX OR EROSION CONTROL MULCH AS DIRECTED BY THE ENGINEER, IS TO BE USED ON AREAS THAT ARE TO BE REGRADED OR LATER DISTURBED, IF LEFT DORMANT FOR MORE THAN 15 DAYS.

EROSION CONTROL MULCH, AS DIRECTED BY THE ENGINEER, IS TO BE USED ON AREAS THAT ARE TO BE LEFT DORMANT FOR MORE THAN 15 DAYS BETWEEN DECEMBER 1 AND FEBRUARY 28.

EROSION CONTROL MULCH AS LISTED ON THE VDOT APPROVED PRODUCTS LIST, SHALL BE APPLIED IN ACCORDANCE WITH THE MANUFACTURER'S RECOMMENDATIONS.

EROSION CONTROL MULCH SHALL PROVIDE 100 PERCENT COVERAGE OF ALL DENUDED AREAS.

SPRING & SUMMER AND FALL & WINTER DEFINED FOR THE PURPOSE OF DETERMINING WHETHER HULLED OR UNHULLED BERMUDAGRASS AND SERICEA LESPEDEZA SEED IS REQUIRED:

SPRING & SUMMER 4/1 - 9/15 - USE HULLED SEED FALL & WINTER 9/15 - 4/1 - USE UNHULLED SEED

TYPE I MULCH (STRAW) TO BE USED ON NEWLY SEEDED AREAS ADJACENT TO ALL WATERWAYS, WETLANDS, SWAMPS, OR ANY AREA IN WHICH DRAINAGE FLOWS TOWARD AREAS UNDER THE JURISDICTION OF THE ENVIRONMENTAL REGULATORY AGENCIES.

TYPE I MULCH SHALL BE APPLIED TO PROVIDE A MINIMUM 90 PERCENT COVERAGE.

TYPE I MULCH SHALL BE TACKED WITH FIBER MULCH AT THE RATE OF 750 LBS. PER ACRE AND/OR MULCH TACKIFIER.

TYPE II MULCH (FIBER MULCH) MAY BE SUBSTITUTED FOR TYPE I MULCH AT THE RECOMMENDATION OF THE ENGINEER.


TYPE II MULCH SHALL BE APPLIED AT A RATE OF 1500 LBS. (NET DRY WEIGHT) PER ACRE TO PROVIDE A MINIMUM OF 90 PERCENT COVERAGE, AND SHALL BE APPLIED IN A SEPARATE APPLICATION.


ALL TOPSOIL IS TO BE FREE OF HARD LUMPS, CLODS, ROCKS AND FOREIGN DEBRIS AND IS TO BE HAND RAKED TO TIE INTO EXISTING LAWNS.

ALL SEED MUST BE IN CONFORMANCE WITH VDOT SEED SPECIFICATIONS FOR GRASSES & LEGUMES AND BE PROVIDED AT THE PROJECT SITE IN BAGS NOT OPENED AND LABELED FOR USE ON VDOT PROJECTS WITH A GREEN TAG CERTIFYING INSPECTION BY THE VIRGINIA CROP IMPROVEMENT ASSOCIATION.

MIX REQUIREMENTS THIS PROJECT

RECOMMENDATIONS FOR THE APPLICATION OF SEED MIXTURES (CORE MIX AND ADDITIVES), FERTILIZER, LIME ETC. ARE TO BE OBTAINED FROM THE ENGINEER.

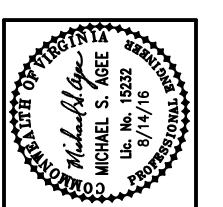

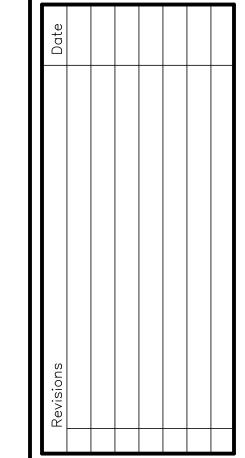

Drawn By: WCB
Designed By: RSM
Checked By: MSA
Date: 8/10/16

ENGINEERS SURVEYORS
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NOKTHSIDE NEIGHBORHOUD IMPROVEMENT PLADILLARD STREET AND ALLEY IMPROVEMENTS
ROADSIDE DEVELOPMENT

Vertical Scale: NO SCALE

Horizontal Scale: NO SCALE

Commission Num

and No:

